
REVISION - RECORD

PROJECT TITLE:

PORT ALBERNI SECONDARY -CHANGE ROOM RENOVATION

4000 ROGER ST, PORT ALBERNI, BC

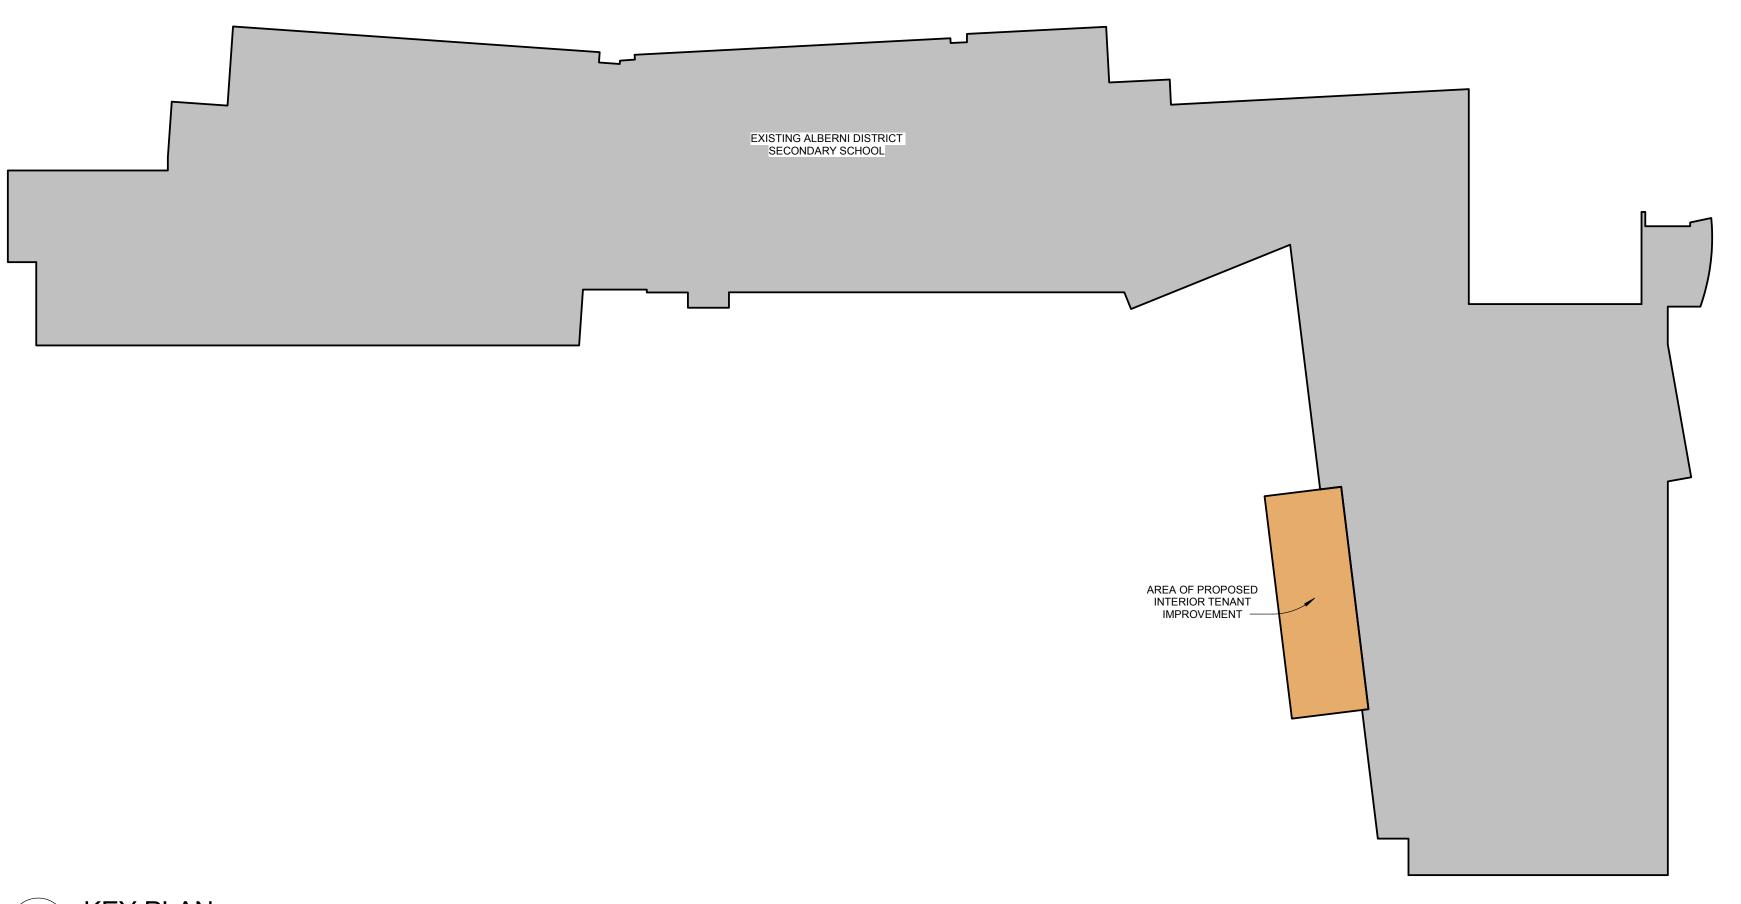

Compton Rd ALBERNI SAHARA HEIGHTS **PROJECT**

SITE LOCATION MAP (N.T.S.)



ABBREVIATION LEGEND

HOLLOW METAL

HOUR

HR

#	POUND OR NUMBER	HVAC	HEATING, VENTILATING, AND AIR CONDITIONING
** &	AND	IRGWB	IMPACT RESISTANT GYPSUM WALL BOARD
	AT	ILO	
@			IN LIEU OF
ACT	ACOUSTIC CEILING TILE	INSUL	INSULATED OR INSULATION
AFF	ABOVE FINISHED FLOOR	INT	INTERIOR
ALUM	ALUMINUM	LO	LOW
ANOD	ANODIZED	MAX	MAXIMUM
BYND	BEYOND	MO	MASONRY OPENING
BOT	BOTTOM	MECH	MECHANICAL
CJ	CONTROL JOINT	MIN	MINIMUM
CLG	CEILING	MRGWB	MOISTURE-RESISTANT GYPSUM WALL BOARD
CLR	CLEAR	MTL	METAL
CMU	CONCRETE MASONRY UNIT	NIC	NOT IN CONTRACT
COL	COLUMN	NO	NUMBER
CONC	CONCRETE	NOM	NOMINAL
CONT	CONTINUOUS	OC	ON CENTER
CPT	CARPET	OSCI	OWNER SUPPLY, CONTRACTOR INSTALL
CSCI	CONTRACTOR SUPPLY, CONTRACTOR INSTALL	OSOI	OWNER SUPPLY, OWNER INSTALL
CT	· ·	PLUMB	· ·
	CERAMIC TILE		PLUMBING
C/W	COMPLETE WITH	PLYD	PLYWOOD
DBL	DOUBLE	PNT/PTD	PAINT OR PAINTED
DEMO	DEMOLISH OR DEMOLITION	PSF	PRESSED STEEL FRAME
DIA	DIAMETER	RBR	RUBBER
DIM/DIMS	DIMENSION/DIMENSIONS	RCP	REFLECTED CEILING PLAN
DN	DOWN	REQD	REQUIRED
DR	DOOR	RM	ROOM
DWG	DRAWING	SIM	SIMILAR
EA	EACH	SPEC	SPECIFIED OR SPECIFICATION
EL	ELEVATION	SPK	SPRINKLER OR SPEAKER
ELEC	ELECTRICAL	SSTL	STAINLESS STEEL
ELEV	ELEVATOR OR ELEVATION	STC	SOUND TRANSMISSION COEFFICIENT
EQ	EQUAL	STL	STEEL
EXIST	EXISTING	STRUCT	STRUCTURE OR STRUCTURAL
EXT	EXTERIOR	TELE	TELEPHONE
FD	FLOOR DRAIN OR FIRE DEPARTMENT	TLT	TOILET
FEC	FIRE EXTINGUISHER CABINET	TME	TO MATCH EXISTING
FIXT	FIXTURE	TO	TOP OF
FLR	FLOOR	TOC	TOP OF CONCRETE
	FACE OF	TOS	TOP OF CONCRETE TOP OF STEEL
FO			
FND	FOUNDATION	TPD	TOILET PAPER DISPENSER
GA	GAUGE	TYP	TYPICAL
GALV	GALVANIZED	UNO	UNLESS NOTED OTHERWISE
GWB	GYPSUM WALL BOARD	U/S	UNDERSIDE
HC	HOLLOW CORE	VIF	VERIFY IN FIELD
HI	HIGH	VP	VISION PANEL

WITH

WOOD

GENERAL NOTES

- ALL WORK SHALL CONFORM TO THE REQUIREMENTS OF BRITISH COLUMBIA BUILDING CODE 2018, ALL APPLICABLE CSA STANDARDS AND ALL LOCAL AND MUNICIPAL BY-LAWS AND
- ALL WORK SHELL BE EXECUTED ACCORDING TO THE BEST TRADE PRACTICES, BEING
- SQUARE, PLUMB AND TRUE TO LINE. READ, CHECK AND COMPARE ALL DRAWINGS. NOTIFY THE ARCHITECT OF ANY/ALL
- CHECK AND VERIFY EXISTING CONDITIONS AS SHOWN. NOTIFY THE ARCHITECT OF ANY/ALL
- VERIFY ALL DIMENSIONS BEFORE CONSTRUCTION/ FABRIFICATION OF ALL COMPONENTS. DIMENSIONS ARE TO FACE OF STUD OR TO FACE OF SHEATHING, GRID LINES, FACE OF
- CONCRETE AND FACE OF MASONRY WALLS EXCEPT AS NOTED. GLAZING DIMENTIONS ARE FRAME DIMENSIONS U.N.O.
- REFER TO WALL SCHEDULES FOR WALL TYPES (TO BE READ IN CONJUNCTION WITH ALL DRAWINGS INCLUDING PLANS, WALL SECTIONS AND DETAILS, ETC.)
- SOUND INSULATED WALLS (ACOUSTIC PARTITIONS): GYPSUM WALLBOARD TO BOTH SIDES OF WALL SHALL CONTINUE TO UNDERSIDE OF DECK, FLOOR OR ROOF STRUCTURE, AND TO BE COMPLETE WITH SOUND SEALS AT DECK FLUTES AT TOP OF WALL AND ACOUSTIC SEALANT AT TOP AND BOTTOM OF WALLS ON BOTH SIDES. SOUND INSULATE AROUND ALL OFFICES, WASHROOMS, CHANGE ROOMS AND WHERE INDICATED ON PLANS.
- FOR FIRE SEPARATIONS AND ASSEMBLY RATINGS, REFER TO CODE ANALYSIS/ COMPLIANCE DRAWINGS, FLOOR PLANS AND WALL SCHEDULES.
- CONTINUITY OF FIRE SEPARATION I.E. CONTINUITY OF GWB TO BE MAINTAINED AT INTERVENING NON RATED PARTITIONS, BEHIND MILLWORK, SHOWERS, RECESSED ELECTRICAL PANELS & FIRE EXTINGUISHERS, ETC.
- PROVIDE SOLID BLOCKING IN WALLS & FLOORS FOR ALL WALL MOUNTED FIXTURES, ACCESSORIES, EQUIPMENT, MILLWORK, ETC WHERE AND AS REQUIRED. FOR LOCATION OF WASHROOM ACCESSORIES, REFER TO CORRESPONDING WASHROOMS PLANS AND DETAILS.
- FOR INTERIOR FINISHES REFER TO INTERIOR ELEVATIONS AND ROOM AND FINISH
- ITEMS CROSS-HATCHED OR MARKED "N.I.C." ARE "NOT IN CONTRACT". \
- PROVIDE BLOCKING IN WALLS & FLOORS AS REQUIRED. FOR CONCRETE HOUSEKEEPING PADS SEE STRUCTURAL, MECHANICAL AND ELECTRICAL
- FOR FLOOR DRAINS ALSO SEE MECHANICAL. WHERE COMPARTMENTALIZATION OF CONCEALED SPACES IS REQUIRED BY CODE, PROVIDE MIN. 0.38mm THICK METAL SHEET CLOSURES TO SUIT AT MAX. 20 m HORIZONTALLY AND AT 3 m VERTICALLY AT EACH FLOOR LEVEL. THIS INCLUDES ALL RAINSCREEN CAVITIES GREATER THAN 25mm THAT CONTAIN COMBUSTIBLE INSULATION AND OTHER ELEMENTS. CLOSURES MUST BE SUFFICIENT TO STOP THE SPREAD OF FLAME AS PER BCBC AND ACCEPTABLE TO THE AUTHORITY HAVING JURISDICTION.
- PROVIDE FIRE PROTECTION TO STRUCTURE AS REQUIRED PER CODE COMPLIANCE TABLE. PROVIDE SHOP DRAWINGS SUBMITTALS FOR ALL SECONDARY COMPONENTS & THEIR ATTACHMENTS. THE COMPONENTS SHALL BE DESIGNED; DRAWINGS SIGNED & SEALED BY THE SPECIALTY P.ENG. C/W LETTERS OF ASSURANCE.

ARCHITECTURAL DRAWING LIST

A0.0.1 SURVEY DEMO FLOOR PLANS A2.0.1

MAIN FLOOR PLAN A2.2.1 FLOOR FINISH & INTERIOR PLAN A3.1.1 REFLECTED CEILING PLANS

A7.1.1 INTERIOR ELEVATIONS A9.1.1 TYPICAL INTERIOR DOOR & SCREEN FRAME DETAILS

A9.2.1 DOOR SCHEDULE C/W TYP DOOR ELEVATIONS INTERIOR GLAZED SCREEN SCHEDULE

ELECTRICAL DRAWING LIST

COVER SHEET

MECHANICAL DRAWING LIST

COVER SHEET

STRUCTURAL DRAWING LIST

COVER SHEET

CONTACT LIST

GREG ROE SCHOOL DISTRICT NO. 70

4690 ROGER STREET PORT ALBERNI, BC (P) 250-723-8821 (E) GROE@SD70.BC.CA

ARCHITECTURAL VALERIE O'LEARY KMBR ARCHITECTS & PLANNERS INC. 300-152 W. HASTINGS ST.,

VANCOUVER, B.C. V6B 1G8 (P) 604 - 732 - 3361, (E) VOLEARY@KMBR.COM

STRUCTURAL LEE ROWLEY HEROLD ENGINEERING LTD. 3701 SHENTON ROAD NANAIMO, BC V9T 2H1 (P) 250-751-8558,(E)...

MECHANICAL STEPHEN MCNICHOLLS SMCN CONSULTING INC. NANAIMO, BC

(P) 250-616-3232, (E) STEPHEN@SMCN.CA

ELECTRICAL LES BROWN RB ENGINEERING LTD. 1850 NORTHFIELD ROAD

NORTH

NANAIMO, BC V9S 3B3 (P) 250-756-4444, (E) LES@RBENGINEERING.COM

REVISION - RECORD

DATE

DEMO FLOOR PLAN LEGEND

EXISTING WALL TO REMAIN

EXISTING DOOR IN EXISTING

EXISTING DOOR AND FRAME TO

EXISTING WINDOWS AND ASSOCIATED COMPONENTS TO

GUARDRAILS TO BE REMOVED

CUT AND PATCH EXISTING FLOOR

EXTENT OF DEMOLITION AND/OR NOTE

DEMOLITION KEYNOTES INDICATOR

EXISTING GWB. CEILING TO BE REMOVED

EXISTING LIGHT FIXTURES TO BE REMOVED

EXISTING MECHANICAL EQUIPMENT TO BE REMOVED

EXISTING MILLWOK, FIXTURES, STAIRS AND

FRAME TO REMAIN

BE REMOVED

BE DEMOLISHED

EXISTING WALL TO BE DEMOLISHED

PROJECT TITLE: **PORT ALBERNI SECONDARY -CHANGE ROOM** RENOVATION

4000 Roger St, Port Alberni, BC V9Y 0B1

SCHOOL DISTRICT NO. 70 (ALBERNI)


DRAWING TITLE: **DEMO FLOOR PLANS**

PROJECT NUMBER:


DRAWN: VOL

DATE: **04/23/20** DRAWING NUMBER:

A2.0.1

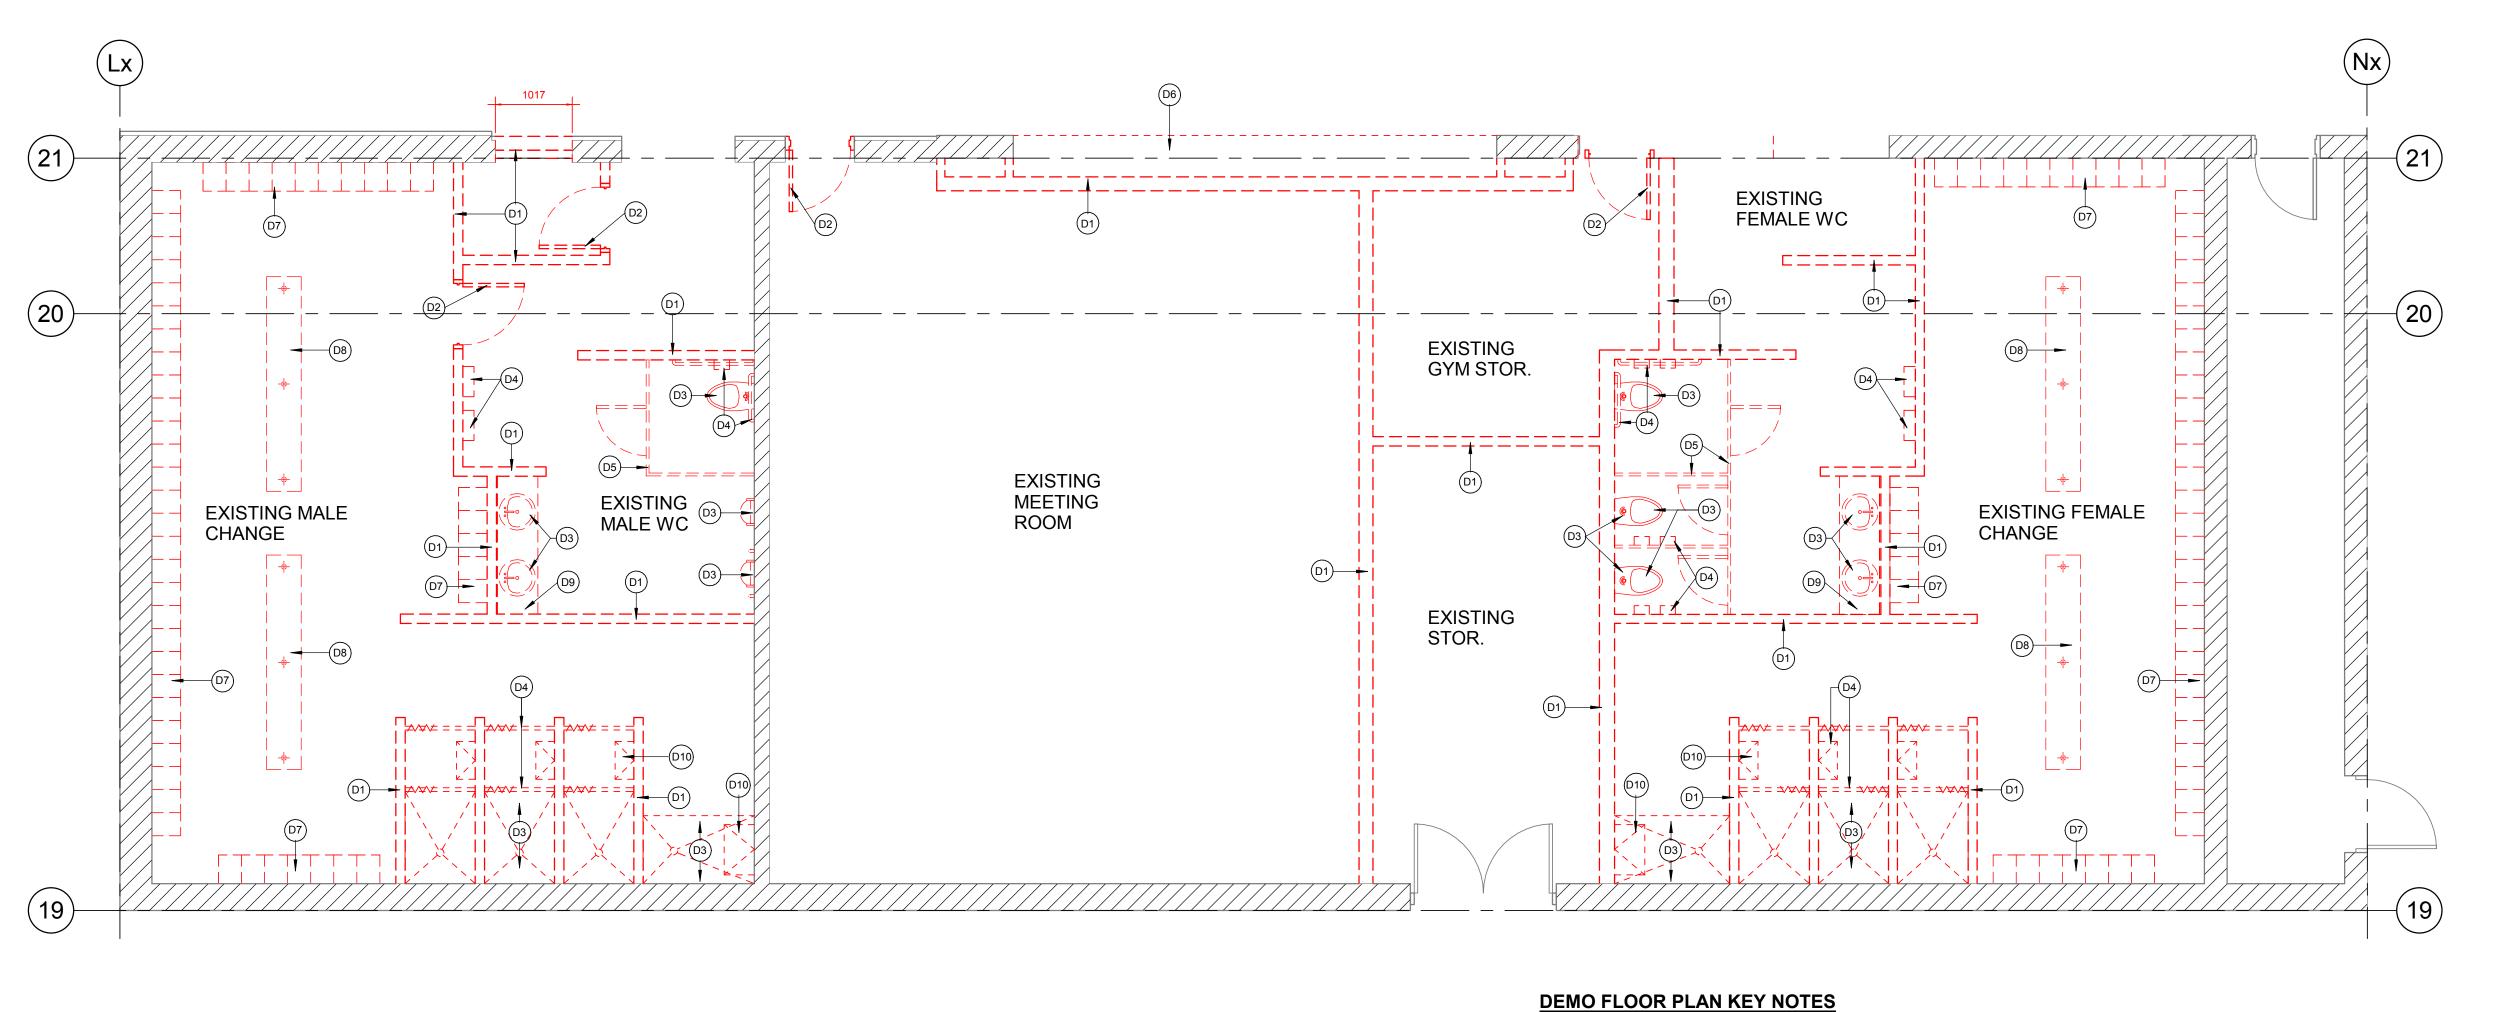

1 A200 - MAIN FLOOR - DEMO

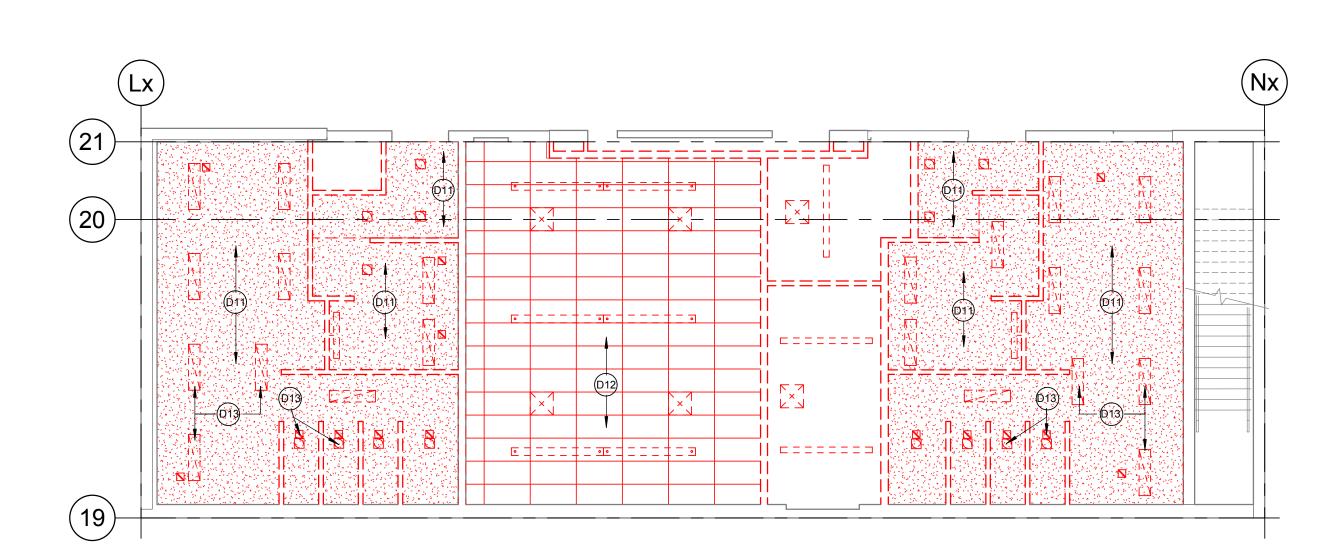

MAIN FLOOR REFLECTED CEILING PLAN - DEMO

D1 - REMOVE EXISTING STUD WALLS.

REMOVE EXISTING DOOR AND FRAME FROM STUD WALL. - TO BE REUSED IN NEW SPACE -

REFER TO DOOR SCHEDULE ON A9.1.1

REMOVE EXISTING PLUMBING FIXTURES - TO BE REUSED IN NEW SPACE.

REMOVE EXISTING WASHROOM ACCESSORIES - TO BE REUSED IN NEW SPACE REMOVE EXISTING WASHROOM PARTITIONS AND DOORS.

REMOVE EXISTING MILLWORK DISPLAY CABINET. REMOVE EXISTING LOCKERS AND TURN OVER TO OWNER.

REMOVE EXISTING BENCH AND TURN OVER TO OWNER REMOVE EXISTING MILLWORK VANITY.

REMOVE EXISTING WALL MOUNTED BENCH. RE-USE IN PROPOSED SH 111 & SH 118 REMOVE EXISTING GWB. CEILING

D12 - REMOVE EXISTING T-BAR AND ACOUSTIC CEILING TILE.

D13 - REMOVE EXISTING LIGHT FIXTURE - RETAIN FOR USE IN NEW SPACE D14 - REMOVE EXISTING MECHANICAL EQUIPMENT.

DEMO FLOOR PLAN NOTES

CONTRACTOR TO NOTIFY DESIGN CONSULTANT & OWNER OF ANY MODIFICATIONS

REQUIRED TO THE BASE BUILDING DEMOLITION PRIOR TO COMMENCEMENT OF WORK. ALL DRAWINGS ARE TO BE VERIFIED BY THE CONTRACTOR WITH REFERENCE TO EXISTING CONDITIONS. VERIFY ALL DIMENSION BEFORE DEMOLITION.

KEYNOTES ARE TO HIGHLIGHT GENERAL DEMOLITION REQUIREMENTS ONLY. READ IN CONJUNCTION WITH ALL ARCHITECTURAL ALL CONSULTANT DRAWINGS. DEMOLITION OF ANY EXISTING STRUCTURAL SLAB, WALLS, FOUNDATIONS AND OPEN WEB JOISTS ARE TO BE APPROVED BY STRUCTURAL ENGINEER PRIOR TO COMMENCEMENT OF

MATCH, PATCH AND REPAIR FINISHES AS NECESSARY TO MATCH ADJACENT EXISTING

FINISHES (SEE ALSO ROOM FINISH SCHEDULE).

SEE ALSO REFLECTED CEILING PLANS FOR DEMOLITION WORK. WALLS, DOORS, ROOFS, FLOORS, STAIRS, WINDOWS AND MILLWORK TO BE REMOVED ARE SHOWN WITH A DASHED LINE: REMOVE ALL ATTACHMENTS (E.G. SPEAKERS, CLOCKS, SHELVING UNITS, TACKBOARD ETC.) AND TURN OVER TO OWNER.

EXISTING STRUCTURE TO REMAIN UNLESS NOTED OTHERWISE. REMOVE ALL FLOOR FINISHES WHERE NOTED IN RENOVATED AREAS AND SCRAPE OFF WALL GLUE OR RESIDUE SO THAT SUB-FLOOR IS CLEAN AND SMOOTH BEFORE RECEIVING NEW UNDERLAYMENT AND FINISHES SPECIFIED.]

SEE EXTERIOR ELEVATIONS FOR ADDITIONAL DEMOLITION WORK. (E.G. YARD LIGHTS, MECHANICAL, GRILLES AND HOODS, OUT-BUILDINGS ETC.) REFER ALSO TO DETAILS AND RENOVATION PLANS FOR LOCATIONS WHERE DEMOLITION IS

REQUIRED BY NEW CONSTRUCTION. CONFIRM WITH STRUCTURAL ENGINEER BEFORE COMMENCING ANY DEMOLITION OF LOAD-BEARING STRUCTURE (E.G. WALLS, COLUMNS, BEAMS ETC.)

WHERE NOTED, ALL EXISTING EXTERIOR WINDOWS, TRIMS AND SILLS ARE TO BE REMOVED AND REPLACED WITH NEW WINDOWS AS SHOWN ON EXTERIOR ELEVATIONS. WHERE NOTED, ALL EXISTING EXTERIOR WALL AND ROOF FINISHES ARE TO BE STRIPPED

DOWN TO EXISTING SHIPLAP AND ALL INTERIOR FINISHES ARE TO BE STRIPPED DOWN TO EXISTING WOOD STUDS. REMOVE ALL EXISTING INSULATION IN WALLS, CEILING AND ROOF SPACES.

REVIEW ASBESTOS REPORT FOR LOCATION, HANDLING AND DISPOSAL OF HAZARDOUS SEE CIVIL AND LANDSCAPE DRAWINGS FOR EXISTING SITE ELEMENTS TO BE REMOVED INCLUDING UNDERGROUND UTILITIES, STAIRS & LANDINGS, RAMPS, HARD SURFACES AND

WHERE EXISTING MILLWORK IS REMOVED, ENSURE SERVICES ARE CAPPED OFF SAFELY PRIOR TO DEMOLITION (CO-ORDINATE WITH MECHANICAL & ELECTRICAL) TURN OVER TO OWNER SINKS, ACCESSORIES AND APPLIANCES WHERE SHOWN ON DRAWINGS.

PROJECT TITLE: **PORT ALBERNI SECONDARY -CHANGE ROOM** RENOVATION

4000 Roger St, Port Alberni, BC V9Y 0B1

SCHOOL DISTRICT NO. 70 (ALBERNI)

DRAWING TITLE:

MAIN FLOOR PLAN


PROJECT NUMBER:

DRAWN: **VOL** SCALE: As

DATE: **05-12-20**

PROJECT

DRAWING NUMBER:

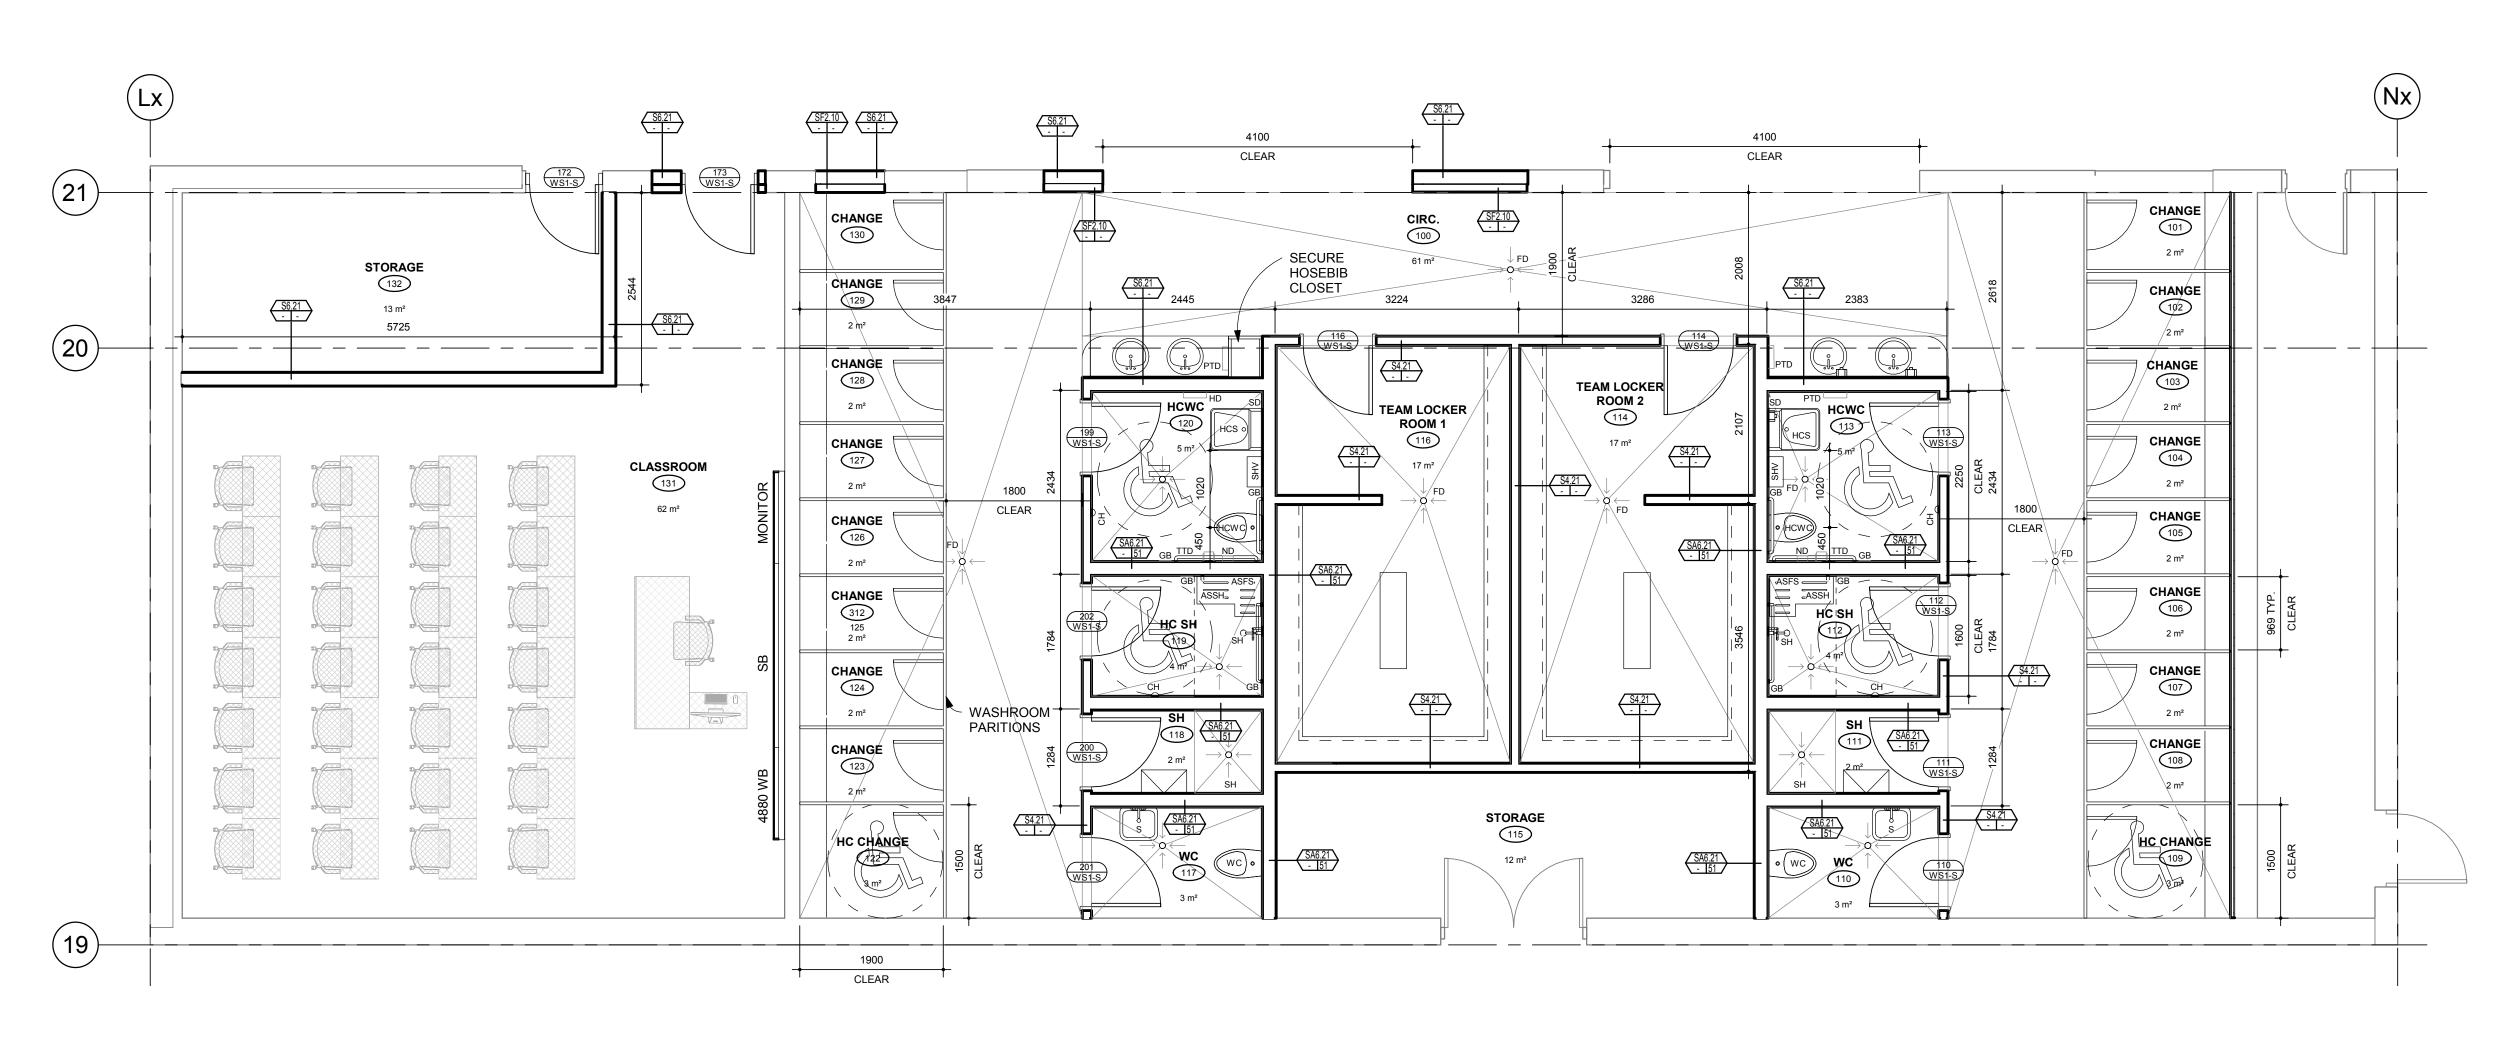




WALL LEGEND			
FIRE SEPARATIONS		WALL TAG EXAMPLE	✓ WALL TYPE
PATTERN FRR		\(\frac{\sqrt{844.42E}}{2.1}\)	
	0 HR	REQUIRED FRR (HR)	REQUIRED STC
	3/4 HR	WALL TYPE NOMENCLATURE:	
	1 HR	SUFFIX 'A' (EG. S#A) = 0 HR FII SUFFIX 'B' (EG. S#B) = 3/4 HRF SUFFIX 'C' (EG. S#C) = 1 HR FII	IRE SEPARATION
	2 HRS	SUFFIX 'D' (EG. S#D) = 1 1/2 HF SUFFIX 'E' (EG. S#E) = 2 HRS F	R FIRE SEPARATION

INTERIOR WALL SCHEDULE NOTES

- RATINGS REFERENCE BC BUILDING CODE 2018, EXCEPT WHERE OTHERWISE STATED. ASSEMBLIES DESCRIBE BASIC REQUIREMENTS TO MEET RATING REQUIREMENTS, ADDITIONAL FINISHES MAY BE REQUIRED AS NOTED IN THE SPECIFICATIONS AND/OR ON
- THE DRAWINGS. THIS SCHEDULE DOES NOT SUPERCEDE OTHER CONTRACT DOCUMENTATION AND IS TO BE READ IN CONJUNCTION WITH ALL OTHER DOCUMENTATION. FOR OTHER CONSTRUCTION SPECIFIC OR TECHNICAL REQUIREMENTS REFER TO THE
- SPECIFICATIONS AND DRAWINGS. REFER TO CODE COMPLIANCE DRAWINGS FOR LOCATIONS OF REQUIRED FIRE RATED
- SEPARATIONS. * REFER TO ROOM FINISH SCHEDULE FOR LOCATIONS FOR IMPACT RESISTANT TYPE 'X' GWB AND IMPACT AND MOISTURE RESISTANT TYPE 'X' GWB. CEMENTITIOUS BACKER BOARD AND 0.15mm POLYETHYLENE TO 2200mm AFF. IMPACT AND MOISTURE RESISTANT TYPE 'X' GWB ABOVE REQUIRED IN ROOMS: 3.06, 3.07, 7.15
- REFER TO FLOOR PLANS FOR REQUIRED RATING AND LOCATIONS PROVIDE SOLID BLOCKING IN WALLS FOR ALL WALL MOUNTED EQUIPMENT, FIXTURES AND MILLWORK.

INTER	IOR STEEL STUD WALL ASSEMBLIES SCHEDI	<u>JLE</u>		
TYPE		(Note 6) STC	(Note 4) FRR	(Note 1) ULC
S3.20	16 MM TYPE 'X' GYPSUM BOARD 92 MM STEEL STUDS @ 406 MM O.C. 16 MM TYPE 'X' GYPSUM BOARD	-	-	-
S6.21	16 MM TYPE 'X' GYPSUM BOARD 152 MM STEEL STUDS @ 406 MM O.C. 150 MM ACOUSTICAL BATT INSULATION 16 MM TYPE 'X' GYPSUM BOARD	-	-	-
SA6.21	16 MM TYPE 'X' GYPSUM BOARD 152 MM STEEL STUDS @ 406 MM O.C. 150 MM ACOUSTICAL BATT INSULATION 16 MM TYPE 'X' GYPSUM BOARD	51	-	-
\$4.21	16 MM TYPE 'X' GYPSUM BOARD 92 MM STEEL STUDS @ 406 MM O.C. 89 MM ACOUSTICAL BATT INSULATION 16 MM TYPE 'X' GYPSUM BOARD	-	-	-

TVDE		(Note 6)	(Note 4)	(Note 1)
TYPE		`STC ′	` FRR ´	` ULC ´
SF2.10 <	25 MM AIR GAP (UNLESS OTHERWISE NOTED ON DRAWINGS) 41 MM STEEL STUDS @ 406 MM O.C. 16 MM TYPE 'X' GYPSUM BOARD	-	-	-

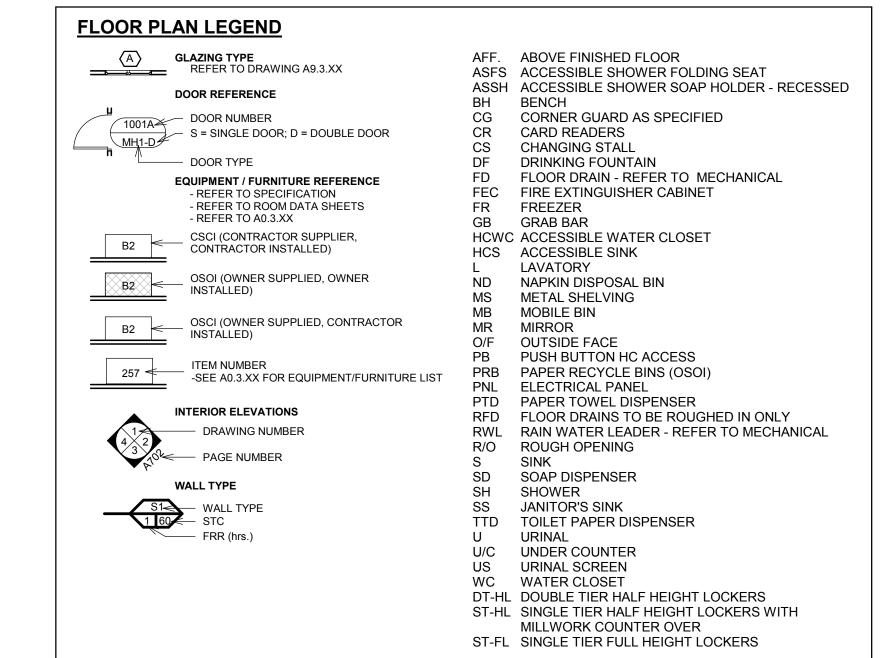

REVISION - RECORD

DESCRIPTION

No. DATE

KMBR ARCHITECTS PLANNERS INC

300-152 W. HASTINGS ST., VANCOUVER, B.C. V6B 1G8 (P) 604 - 732 - 3361 (F) 604 - 732 - 1828 INFO@KMBR.COM WWW.KMBR.COM

FLOOR FINISH & INTERIOR PLAN

PROJECT NUMBER:


DRAWING TITLE:

20354

DRAWN: Author SCALE: 1:50

DATE: **05/13/20**DRAWING NUMBER:

A2.2.1

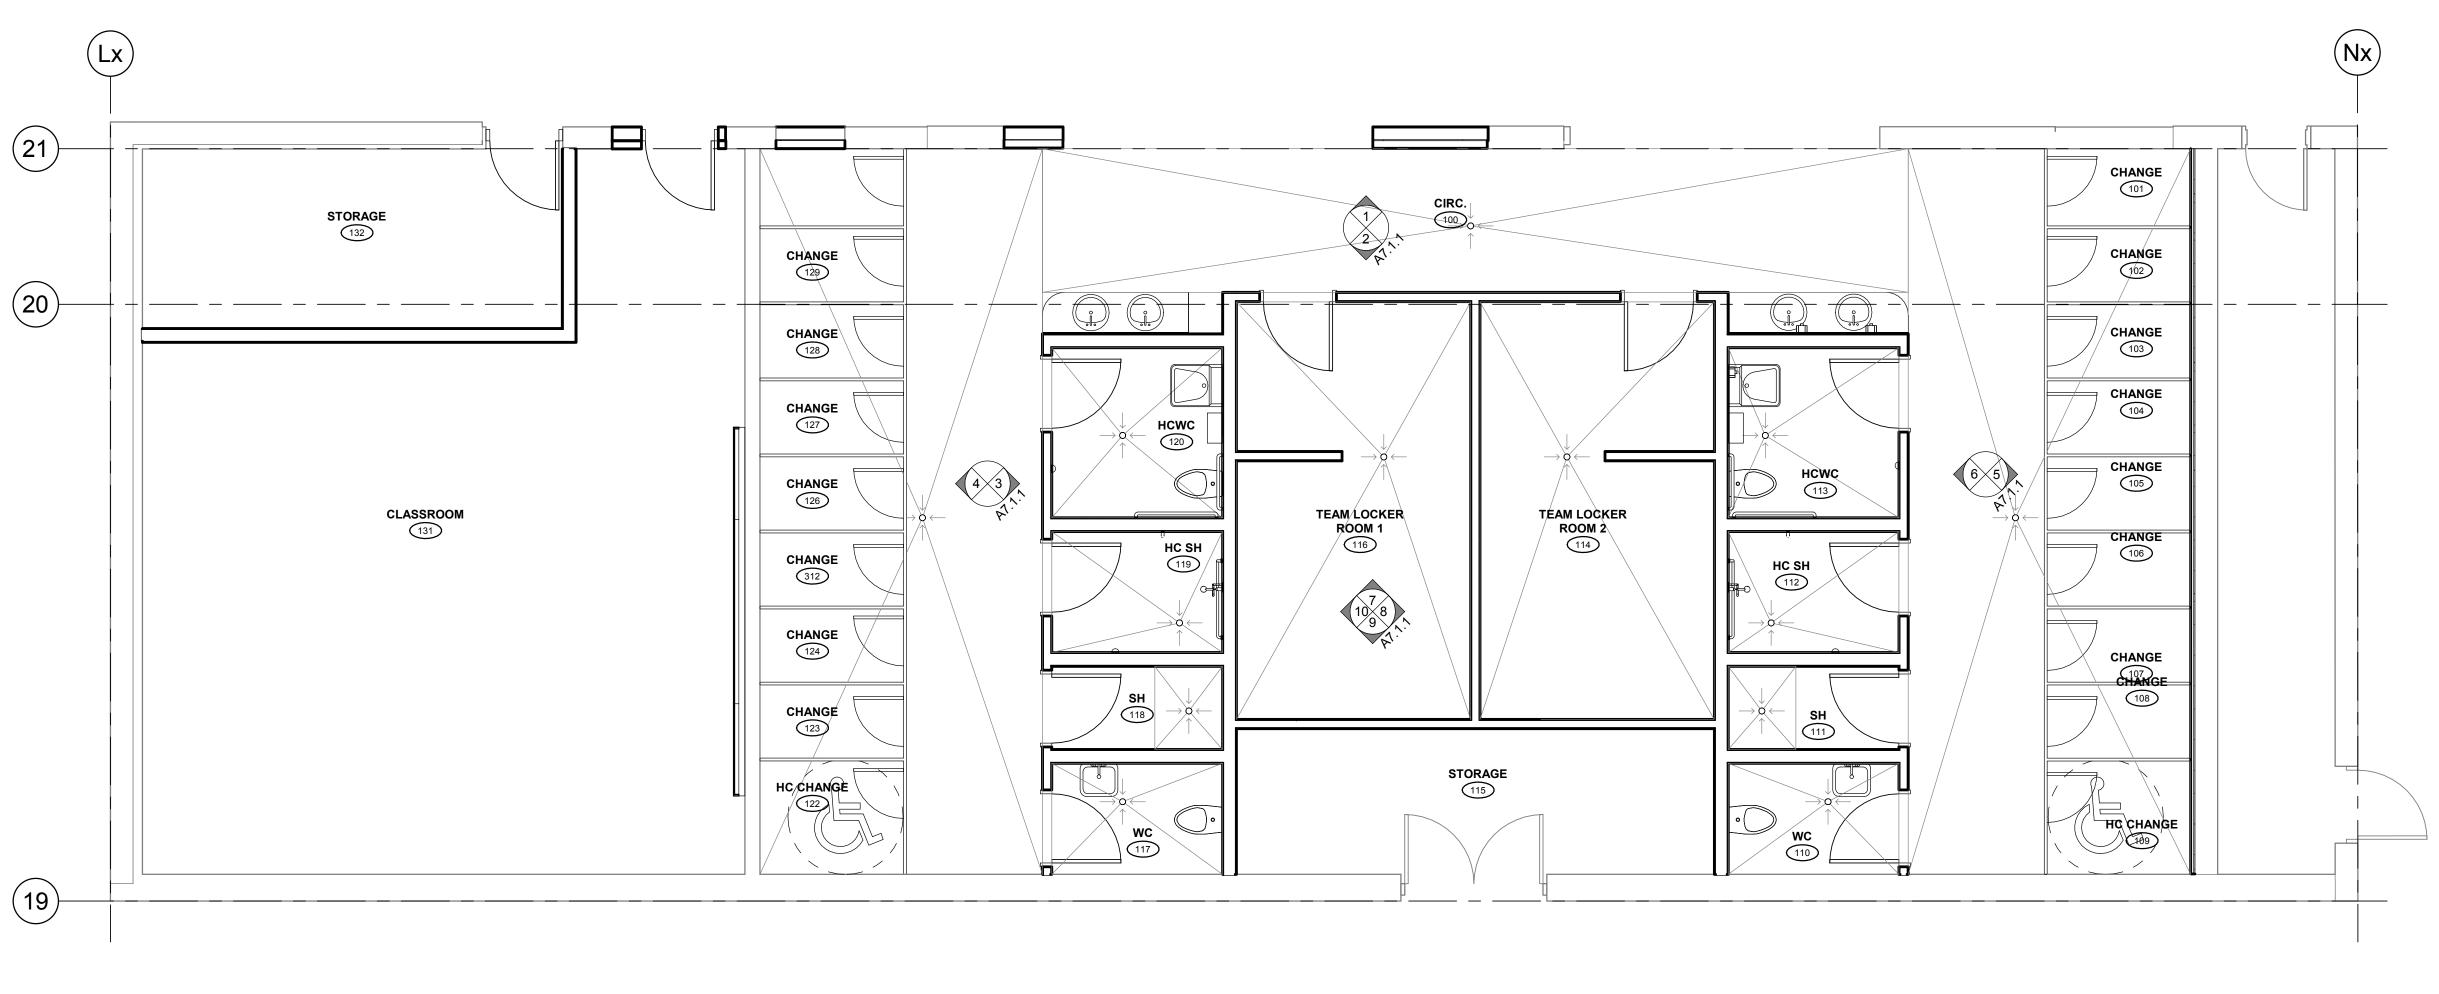

1 A202 - MAIN FLOOR - FINISH PLAN

5/19/2020 7:30:30 PW

PROJECT TITLE: **PORT ALBERNI SECONDARY -CHANGE ROOM RENOVATION**

4000 Roger St, Port Alberni, BC V9Y 0B1

SCHOOL DISTRICT NO. 70 (ALBERNI)


DRAWING TITLE: REFLECTED CEILING **PLANS**

PROJECT NUMBER:

DRAWN: VOL SCALE: As

DATE: **05-12-20** DRAWING NUMBER:

A3.1.1

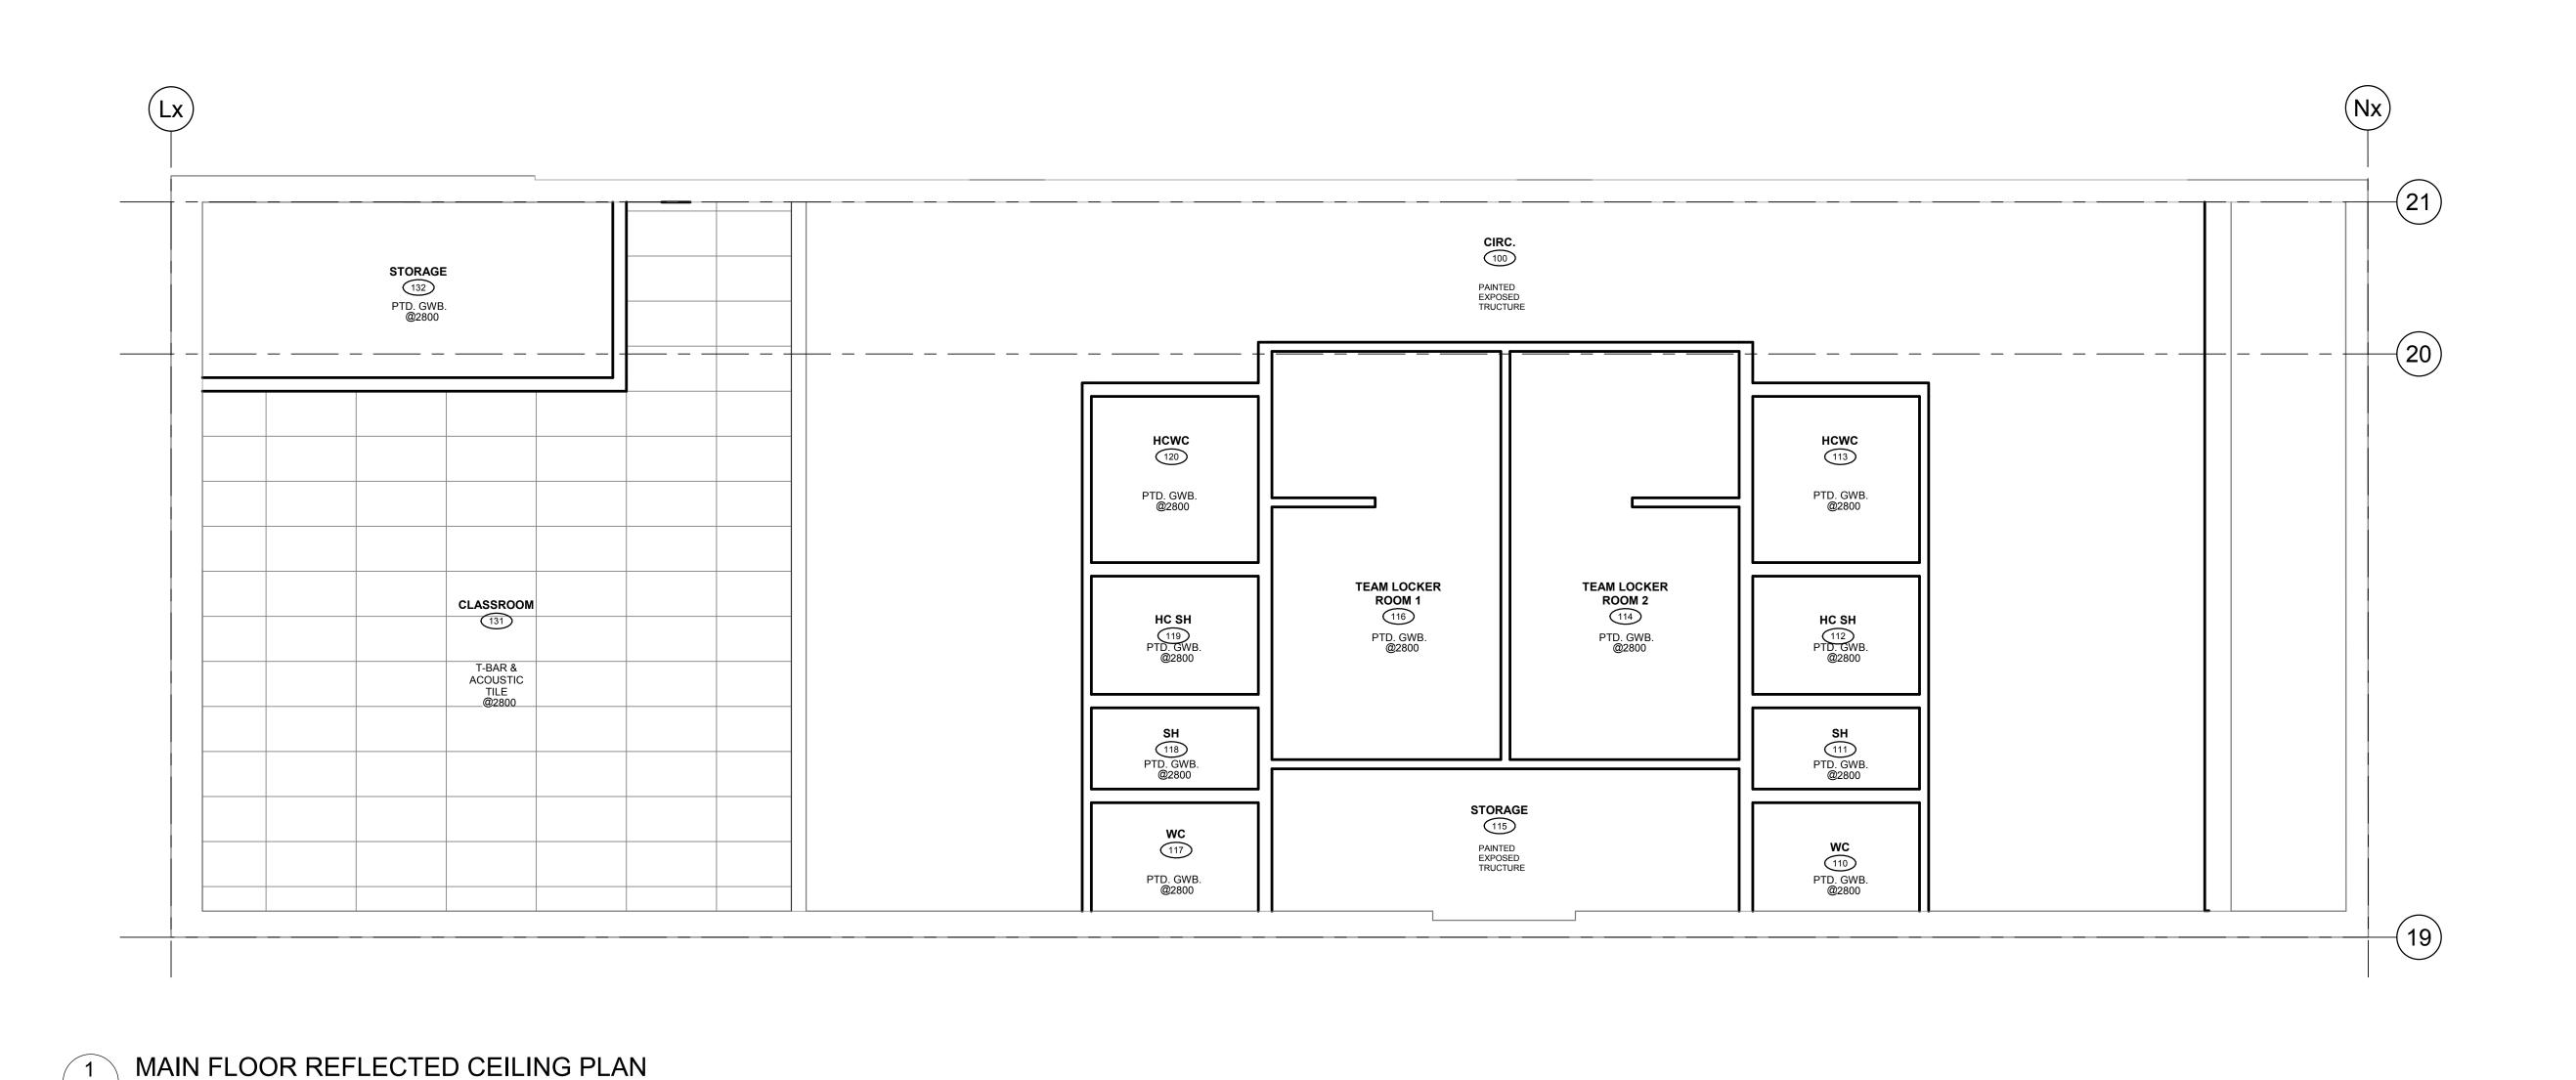



- CEILING HEIGHTS ARE FROM ASSOCIATED FLOOR LEVEL, TOP OF SLAB OR SHEATHING FOR EXTENT & HEIGHT OF BULKHEADS OVER DOORWAYS, WINDOWS & SCREENS,
- COORDINATE WITH DOORS, WINDOWS & SCREENS SCHEDULES ALL EXPOSED MECHANICAL DUCTS, PLUMBING/ SPRINKLER LINES, ELECTRICAL CONDUITS &
- STRUCTURE TO BE PAINTED U.N.O.
- REFLECTED CEILING PLANS ARE TO BE READ IN CONJUNCTION WITH SPECIFICATIONS,
- ROOM FINISHES SCHEDULE, ROOM DATA SHEETS AND INTERIOR DETAILS REFER ALSO TO MECHANICAL, ELECTRICAL, LIGHTING & FIRE PROTECTION DRAWINGS PROVIDE ACCESS PANELS WITH F.R.R. AS REQUIRED TO MATCH ASSEMBLIES BEING

REFLECTED CEILING PLAN LEGEND

GYPSUM WALL BOARD CEILING (PAINTED)

16mm THICK 610mm x 1220mm ACOUSTIC CEILING TILE IN SUSPENDED T-BAR GRID, UNLESS NOTED OTHERWISE

LIGHT FIXTURE-SEE ELEC. DWGS.

> CEILING OR PENDANT MOUNTED LUMINAIRE - SEE ELEC. DWGS.

> > -SEE MECH. DWGS.

MECHANICAL SUPPLY DUCT RISER/ SECTION - SEE MECH.

MECHANICAL RETURN & EXHAUST GRILLE - SEE MECH.

MECHANICAL SUPPLY DIFFUSER

PROJECT

MECHANICAL OUTDOOR AIR DUCT RISER/ SECTION - SEE MECH. DWGS.

PENETRATE PROVIDE FIRE PROTECTION TO STRUCTURE AS REQUIRED PER CODE COMPLIANCE DRAWINGS

PORT ALBERNI SECONDARY -**CHANGE ROOM RENOVATION**

4000 Roger St, Port Alberni, BC V9Y 0B1

SCHOOL DISTRICT

NO. 70 (ALBERNI)


DRAWING TITLE: INTERIOR **ELEVATIONS**

PROJECT NUMBER:

SCALE: As DRAWN: Author DATE: **06/07/19**


DRAWING NUMBER:

A7.1.1

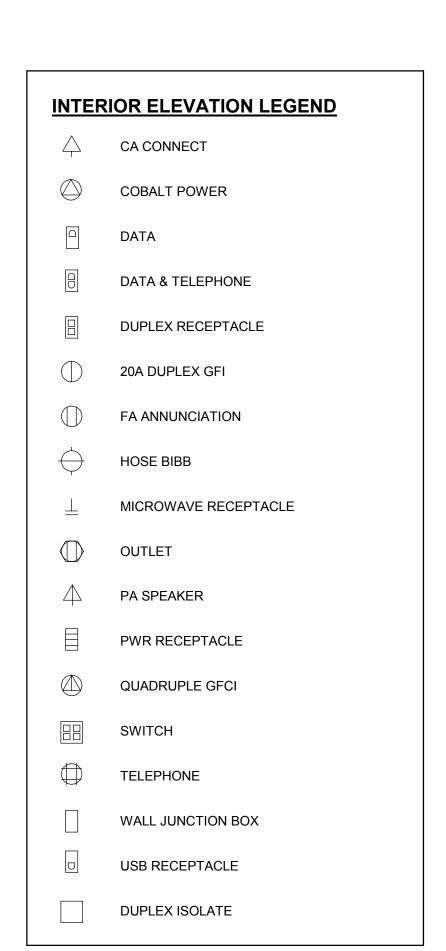


INTERIOR ELEVATION NOTES


- ELEVATIONS ONLY SHOW THE LOCATION OF M&E FIXTURES, FOR TYPE AND NUMBER OF M&E
- FIXTURES REFER TO MECHANICAL AND ELECTRICAL DWGS REFER TO SPECIFICATIONS SECTION 06 40 00 ARCHITECTURAL WOODWORK FOR MILLWORK
- FOR DOOR AND GLAZING INFORMATION REFER TO FLOOR PLANS AND A9.1.1 THROUGH TO
- FOR MILLWORK AND EQUIPMENT INFORMATION REFER TO SPECS, FLOOR PLANS, AND A0.3.XX

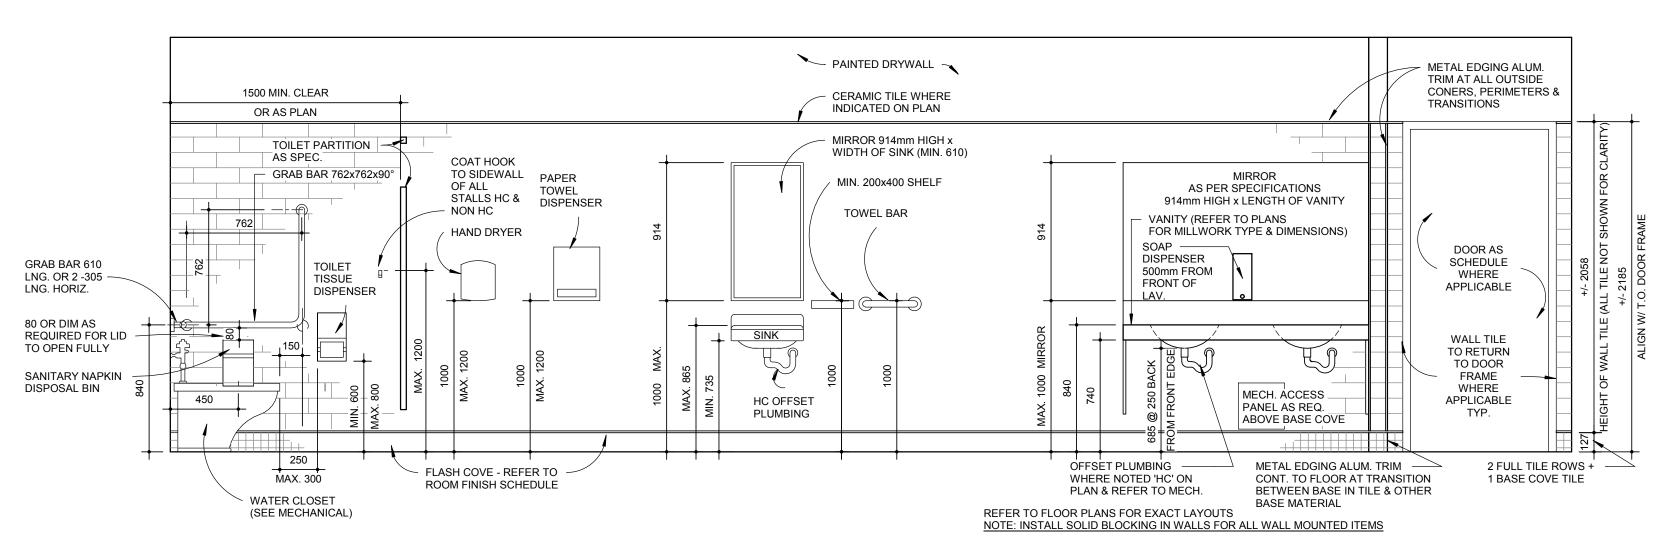



TYPICAL WASHROOM MOUNTING HEIGHTS/DETAILS

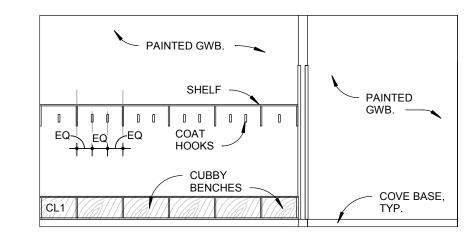



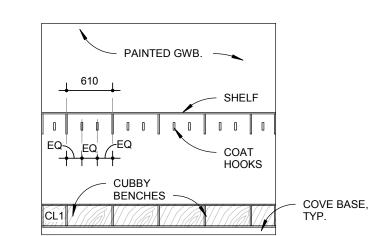

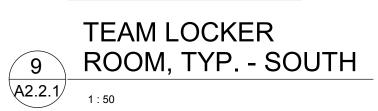

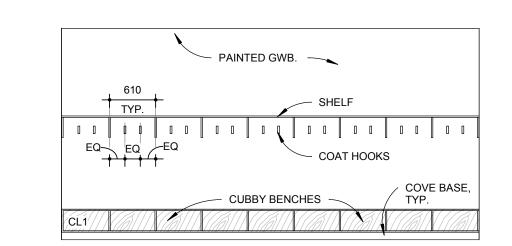





PAINTED GWB.


WASHROOM PARTITIONS W/

GAPLESS DOOR HARDWARE

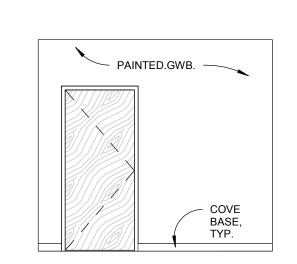

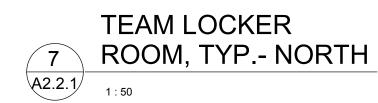

3 CIRC. EAST A

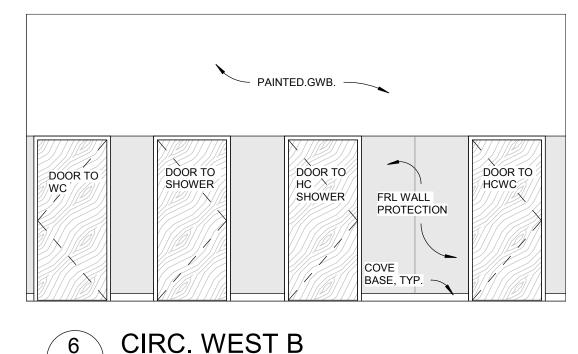

PAINTED


GWB.

- MIRROR -

DOOR TO TEAM LOCKER

/ROOM 2/,



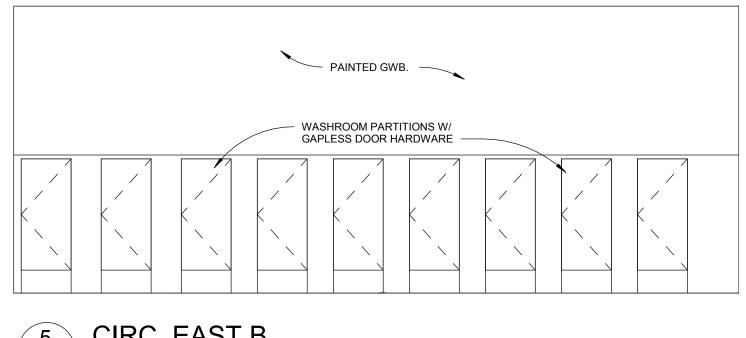

PAINTED

SECURE

STORAGE

CUPBOARD

GWB. ———

- MIRROR -



DOOR TO TEAM LOCKER

ROOM 1


PAINTED.GWB.

COVE BASE, TYP.


FRL WALL


ARMADA LOGO


PROTECTION W/ ADSS

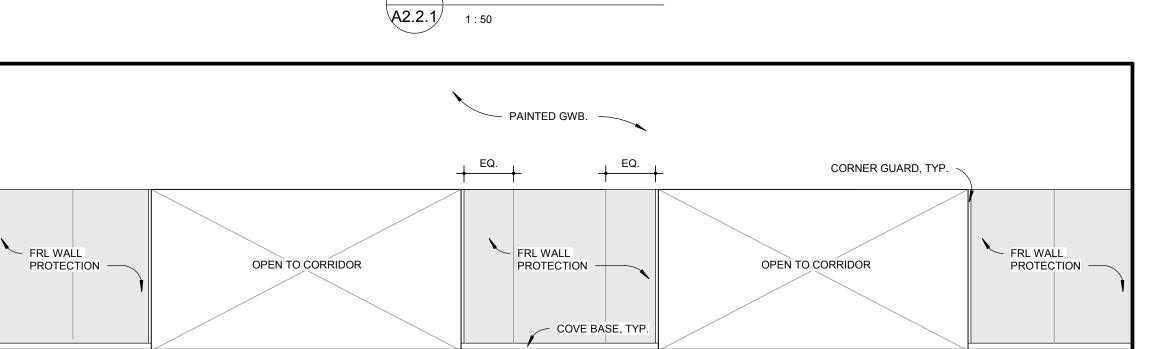

4 CIRC. WEST A

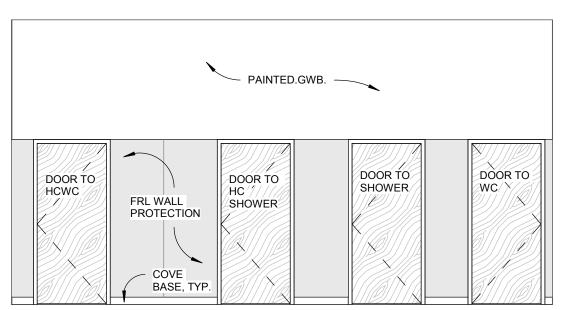

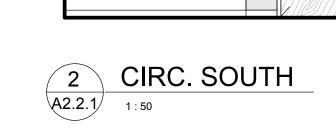

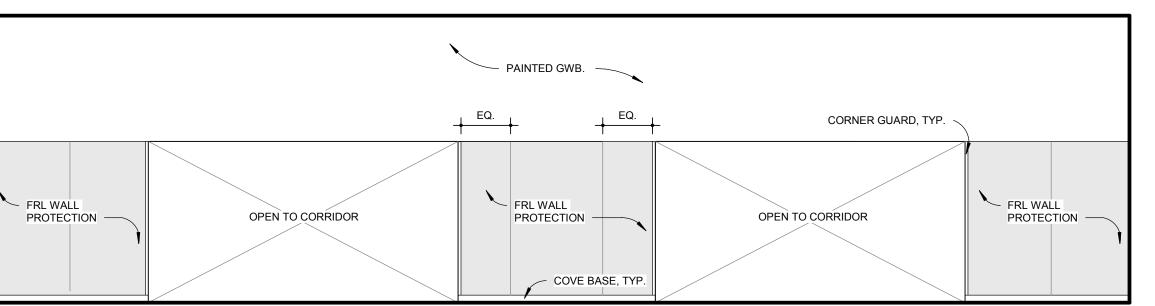

CIRC. NORTH A2.2.1 1:50